These documents must be retained on site. Inspections may not be carried out if they are not.

STRUCTURAL DRAWINGS

WHITES LINE EAST - NEW DWELLINGS FOR C******

FOR BUILDING CONSENT - 11/03/2022

JOB No. 21104

DWG No.	TITLE	REVISION
S0.1	SPECIFICATION SUMMARY SHEET 1	A
S0.2	SPECIFICATION SUMMARY SHEET 2	A
S1.1	FOUNDATION PLAN	В
S1.2	FIRST FLOOR STRUCTURAL PLAN	В
S1.3	ROOF STRUCTURAL PLAN	В
S1.4	GROUND FLOOR BRACING PLAN	В
S1.5	FIRST FLOOR BRACING PLAN	В
S2.1	SECTION Z1	В
S2.2	SECTION Z2	В
S3.1	FOUNDATION DETAILS—1	B
S3.2	FOUNDATION DETAILS—2	A
S4.1	DETAILS-1	A
S4.2	DETAILS-2	A

BUILDING CONSENT

GRANTED 30/03/2022

HUTT CITY COUNCIL

HUTT CITY
TE ARRA KALIDARGI



Level 1, 240 Thorndon Quay PO Box 9586, Marion Square Wellington, 6141 P. (04) 382 8678

12 10 0 20 40 60 80 100 120 140 160 180 200

1.0 CONCRETE

1.1 : THIS IS A STANDARD DRAWING AND TO BE USED AS A GUIDE ONLY. REFER TO JOB DETAILS FOR ALL REINFORCING

1.2 : ENGINEER TO INSPECT ALL WALL REINFORCING ON SITE PRIOR TO CONCRETE POUR.


1.3: THE MINIMUM COMPRESSIVE STRENGTH SHALL BE 25MPa FOUNDATION: 25MPa


SLABS ON GRADE: 25MPa ALL OTHER: 25MPa

BAR BEND DIAMETERS (MIN)			
STEEL GRADE	BAR DIA.	MIN. BEND DIA.	
300 OR 500	6-20	5 db	
300 OK 300	24-40	6 d _b	

BAR BEND DIAMETERS FOR STIRRUPS AND TIES (MIN)				
STEEL GRADE	BAR DIA. MIN. BEND DIA.			
	PLAIN BARS DEFORMED BAR			
300	6-20	2 d _b 4 d _b		
500	6-20	2 d _b	4 d _b	
300	24-40 3 d _b		6 d _b	

LAP LENGTHS		
STEEL GRADE	INSITU CONCRETE	BLOCKWORK
300 OR 500	50 dh	70 dh

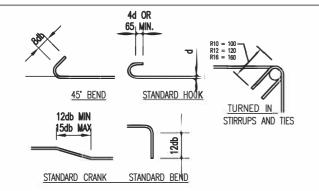

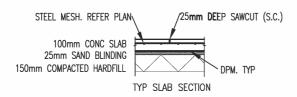

2.0 STEELWORK

2.1 : BOLTING

CONTACT SURFACES AT BOLTED CONNECTIONS SHALL MATCH ACCURATELY AND BE FREE OF DIRT, LOOSE SCALE, PITS AND OTHER DEFECTS. UNLESS OTHERWISE SPECIFIED ON THE DRAWINGS THE MAX SIZE OF THE HOLES FOR THE BOLTS SHALL BE DIAMETER OF THE BOLTS PLUS 2mm. ALL BOLTS SHALL BE TIGHTENED TO A SNUG TIGHT FIT THEN TIGHTENED A FURTHER A 1/4 TURN. WASHERS, TAPERED WHERE NECESSARY, ARE TO BE USED UNDER BOLT HEADS AND NUTS. BOLTS TO BE USED AS FOLLOWS:

TIMBER TO TIMBER AND TIMBER TO STEEL CONNECTION USE ISO METRIC CLASS 4.6 ALL STEEL TO STEEL CONNECTION LISE ISO METRIC CLASS 8.8 ALL STEEL TO CONCRETE CONNECTION USE ISO METRIC CLASS 8.8

ALL SURFACES TO BE WELDED SHALL BE GROUND CLEAN AND COMPLETELY FREE FROM ALL IMPURITIES AND HARMFULL MATTER PRIOR TO WELDING. WELDS TO BE CONTINUOUS BEVEL BUTT OR 5mm CONTINUOUS FILLET WELD (6mm FOR MANUAL WELDS) AS APPROPRIATE UNLESS NOTED

2.3: HOLLOW SECTION HOLLOW SECTION MEMBERS SHALL BE CAPPED AND ALL JOINT SEALED.

THE CONTRACTOR SHALL MAKE FACILITIES AVAILABLE TO THE ENGINEER AT ALL TIMES TO INSPECT ANY PART OF THE WORK IN THE FABRICATING SHOP AND ON THE SITE.

THE ENGINEER HAS THE RIGHT TO REJECT AT ANY STAGE OF FABRICATION, ANY STEEL SHOWING DEFECT OR FAULTY WORKMANSHIP WHICH, IN HIS OPINION, WOULD RENDER THE FINISHED STEELWORK UNSUITABLE.

6V	/ K	7	
FILLET WELD ON 6MM	BUTT WELD	WELD ALL AROUND	SITE WELD

3.0 BOLTS & WASHERS

MAX BOLT SIZE	MIN. WASHER SIZE
8mm	25mm x 25mm x 1.5mm
12mm	50mm x 50mm x 3mm
16mm	64mm x 64mm x 5mm
20mm	75mm x 75mm x 6mm

PROVIDED THAT IF ROUND WASHERS ARE USED THEY SHALL BE OF A THICKNESS AND AREA NOT LESS THAN THOSE SPECIFIED ABOVE FOR THE EQUIVALENT SQUARE WASHER.

4.0 EXCAVATION AND BACKFILLING

4.1 : EXCAVATION

EXCAVATE TO LEVELS AS SHOWN ON THE DRAWINGS EXCAVATION SHALL NOT CAUSE UNDUE DISTURBANCE TO THE GROUND BELOW THE LEVELS OF FINAL TRIMMING

4.2 : FILLING

FILL TO BRING UP TO THE UNDERSIDE OF THE BASECOARSE OR SAND BLINDING AS APPROPRIATE. FILL MATERIAL SHALL BE OF GOOD QUALITY AND OF APPROVED ORIGIN AND ABLE TO BE WELL COMPACTED INTO A DENSE LAYER. NO PARTICLE SIZE SHALL BE GREATER THAN 75MM. SPREAD LOOSE FILL MATERIAL IN LAYERS NOT EXCEEDING 150MM IN THICKNESS AND COMPACTED TO ACHIEVE NOT LESS THAN 95% RELATIVE COMPACTION IN ACCORDANCE WITH NZS4402:1986 PART 4 TEST 4.1.1. NZ STANDARD COMPACTION. THIS STANDARD OF COMPACTION IS REQUIRED THROUGHOUT THE FULL DEPTH OF THE FILL MATERIAL.

COMPACTION MACHINERY MUST BE SUITABLE FOR THE PURPOSE. GENERALLY A HAND OPERATED OR SELF PROPELLED VIBRATING ROLLER OF MEDIUM SIZE WITH A WHACKER USED IN CONFINED SPACES. VIBRATING PLATES SHALL ONLY BE USED ON THIN LAYERS.

THE MOISTURE CONTENT. THE METHOD OF COMPACTION AND THE MATERIAL USED SHALL BE SUCH THAT THE FINISHED RESULT DOES NOT WEAVE WHEN PROOF ROLLED

5.0 ABBREVIATIONS:

В	BOTTOM	EW	EACH WAY
C	CENTRAL	RHS	RECTANGULAR HOLLOW SECTION
C/C	CENTRAL TO CENTRAL	SHS	SQUARE HOLLOW SECTION
CHS	CIRCULAR HOLLOW SECTION	THK	THICK
CJ	CONSTRUCTION JOINT	TYP	TYPICAL
DPM	DAMP PROOF MEMBRANE	UB	UNIVERSAL BEAM
EF	EACH FACE	UC	UNIVERSAL COLUMN

6.0 REINFORCING

D12-250 DENOTES 12MM DIA MS (GRADE 300 MPa) DEFORMED BARS AT 250 C/C. R10-250 DENOTES 10MM DIA MS (GRADE 300 MPa) PLAIN BARS AT 250 C/C. HD12-150 DENOTES 12MM DIA HIGH YIELD (GRADE 500 MPa) DEFORMED BARS AT 150 C/C. HR10-150 DENOTES 10MM DIA HIGH YIELD (GRADE 500 MPa) PLAIN BARS AT 150 C/C.

7.0 INSPECTIONS

7.1: THE ENGINEER IS TO BE ADVISED 48 HOURS BEFORE INSPECTION NEEDED. ENGINEER TO INSPECT ALL STRUCTURAL CONCRETE WORK BEFORE POURING.

7.2: INSPECTION INCLUDE:

COMPLETION OF EXCAVATION & BACKFILLING PREPARATION OF FOUNDATIONS PREPARATION OF STEEL STRUCTURE BEFORE CLOSE IN PREPARATION OF STRUCTURAL TIMBER

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NOTE

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- . ALL WORK AND MATERIAL TO COMPLY WITH THE NEW ZEALAND BUILDING CODE.
- ALL DIMENSIONS IN mm. DO NOT SCALE THE DRAWING.
 USE STATED DIMENSION ONLY
- NEW FOUNDATION TO BE FOUNDED ON "GOOD GROUND" ACCORDING TO NZS3604 CONFIRM ON SITE

J			
	A	BUILDING CONSENT	06/12/2021
	P1	PRELIMINARY	01/12/2021
	No.	Revision/Issue	Date



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	Designed	VM	
j	Drawn	MC	
	Checked	VM	
	Approved	DL	

Project

NEW DWELLINGS

SPECIFICATION SUMMARY SHEET-1

Job No.	Sheet	
21104	S0.1	
Date 01/12/2021		
Scale N/A	Issue A	A3


1.0 TABLE 1: GIB STANDARD PLASTERBOARD BRACING UNIT RATINGS

TYPE	LINING	OTHER REQUIREMENT
GS1-N	GIB STANDARD PLASTERBOARD ONE SIDE	N/A
GS2-N	GIB STANDARD PLASTERBOARD BOTH SIDES	N/A
GSP-H	GIB STANDARD PLASTERBOARD ONE SIDE	N/A

2.0 TABLE 2: GIB BRACELINE BRACING UNIT RATINGS


TYPE	LINING	OTHER REQUIREMENT
BL1-H	GIB BRACELINE ONE SIDE	PANEL HOLD-DOWN FIXINGS
BLG-H	GIB BRACELINE ONE SIDE GIB STANDARD PLASTERBOARD THE OTHER	PANEL HOLD-DOWN FIXINGS
BLP-H	GIB BRACELINE ONE SIDE PLYWOOD THE OTHER	PANEL HOLD-DOWN FIXINGS

3.0 HOLD-DOWN FIXING DETAIL: GIB HANDIBRAC

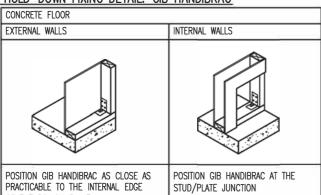

	OF THE BOTTOM PLATE		
TIMBER FLOOR			
	EXTERNAL WALLS	INTERNAL WALLS	
	POSITION GIB HANDIBRAC AS CLOSE AS PRACTICABLE TO THE INTERNAL EDGE OF THE BOTTOM PLATE	POSITION GIB HANDIBRAC AT THE STUD/PLATE JUNCTION	


4.0 GIB EZYBRACE 2016 FASTENER PATTERN

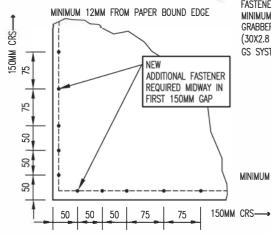

GRABBER SCREWS


FASTENERS: MINIMUM 32MM X 6g GIB (30X2.8 GIB NAILS FOR GS SYSTEMS ONLY)

MINIMUM 18MM FROM CUT SHEET EDGE

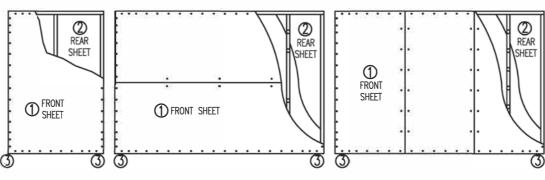

SYSTEM	LINING ONE SI	DE ①	LINING OPPOSIT	E SIDE ②	PANEL HOLD-DOWN	FASTENER SPACING
SISIEM	LINING	FASTENERS	LINING	FASTENERS	FIXING 3	
GS1-N	ANY 10MM	30MM GIB NAILS,	NOT REQUIRED	NOT REQUIRED	NOT REQUIRED	GIB PLASTERBOARD
GS2-N	OR 13MM OR MINIMUM 32MM X 6g PLASTERBOARD GIB GRABBER HIGH THREAD SCREWS	ANY 10MM OR 13MM GIB PLASTERBOARD	30MM GIB NAILS, OR MINIMUM 32MM X 6g GIB GRABBER HICH THREAD SCREWS		CORNER FASTENING PATTERN AS ILLUSTRATED ABOVE FASTENERS AT 150MM TO BRACING ELEMENT PERIMETER, AND: * AT 300MM CENTRES TO INTERMEDIATE SHEET JOINTS FOR VERTICAL FIXING, OR	
GSP-H			MINIMUM 7MM ECOPLY MANUFACTURED TO AS/NZS 2269	50MMX2.8MM FLAT HEAD GALVANISED OR STAINLESS STEEL NAILS	REFER TO 3.0 HOLD-DOWN FIXING DETAIL: GIB HANDIBRAC	*AT STUD/SHEET JUNCTION FOR HORIZONTALLY FIXED ELEMENTS, AND *GIBFIX ADHESIVE DAUBS AT 300MM CRS TO INTERMEDIATE
BL1-H	10MM	MINIMUM	NOT REQUIRED	NOT REQUIRED		FRAMING
BLG-H	OR 13MM 32MM X 6g GIB BRACELINE GRABBER HIGH THREAD SCREWS GIB BRACELINE NAILS MAY BE	ANY 10MM OR 13MM GIB PLASTERBOARD	30MM GIB NAILS, OR MINIMUM 32MM X 6g GIB GRABBER HICH THREAD SCREWS	FASTENERS A THE PERIMET AND AT 3000 INTERMEDIATE	PLYWOOD FASTENERS AT 150MM AROUND THE PERIMETER OF EVERY SHEET AND AT 300MM CENTRES TO INTERMEDIATE STUDS. PLACE FASTENERS NO CLOSER THAN 7MM	
BLP-H		USED FOR 10MM GIB BRACELINE ONLY	MINIMUM 7MM ECOPLY MANUFACTURED TO AS/NZS 2269	50MMX2.8MM FLAT HEAD GALVANISED OR STAINLESS STEEL NAILS		FROM SHEET EDGES. PLASTERBOARD CORNER FASTENER PATTERN DOES NOT APPLY TO PLYWOOD.

6.0 FASTENER SPACING FOR ECOPLY

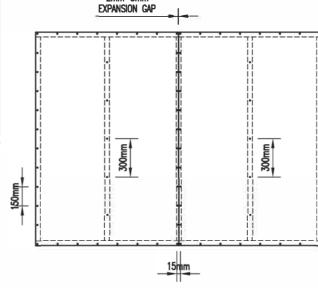

NOTE.

INFORMATION SHOULD BE READ IN CONJUNCTION WITH

- * GIB EZYBRACE SYSTEMS AUGUST 2016 AND
- * ECOPLY SPECIFICATION AND INSTALLATION GUIDE SEPTEMBER 2015 AND
- SEPTEMBER 2017

2mm-3mm

* ECOPLY STRUCTURAL RIGID AIR BARRIER SPECIFICATION AND INSTALLATION GUIDE

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HUTT CITY

Level 1, 240 Thorndon Quay info@focusec.co.nz PO Box 9586, Marion Square www.focusec.co.nz Wellington, 6141 P. (04) 382 8678 **BUILDING CONSENT**

> Designed VM Drawn MC VM Checked DL Approved

A BUILDING CONSENT

FOCUS ENGINEERING CONS

ENGINEERING CONSULTANTS LTD

P1 PRELIMINARY

06/12/2021

01/12/202 Date

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NEW FOUNDATION TO BE FOUNDED ON "GOOD GROUND" ACCORDING TO NZS3604 CONFIRM ON SITE

3. ALL DIMENSIONS IN mm.

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NOTE

Project


Drawing Title

SPECIFICATION SUMMARY SHEET-2

Job No. Sheet 21104 S0.2 Date 01/12/2021 Scale N/A Issue A A3

5.0 ECOPLY BARRIER BRACING

SPECIFICATION NO.	LINING REQUIREMENT	HOLD DOWN	FASTENERS	FASTENING CENTRES
EP1 EPB1	ECOPLY BARRIER ONE SIDE	GIB HANDIBRAC	50x2.8mm HOT DIP GALVANISED OR STAINLESS STEEL FLAT HEAD NAILS. PLACE FASTENERS NO LESS THAN 7MM FROM SHEET EDGES.	150MM CENTRES AROUND THE PERIMETER OF EACH SHEET AND 300MM CENTRES TO INTERMEDIATE STUDS. WHERE MORE THAN ONE SHEET FORMS THE BRACE ELEMENT EACH SHEET MUST BE NAILS OF INDEPENDENTLY
EPBS	ECOPLY BARRIER ONE SIDE	NOT REQUIRED	50x2.8mm HOT DIP GALVANISED OR STAINLESS STEEL FLAT HEAD NAILS. PLACE FASTENERS NO LESS THAN 7mm FROM SHEET EDGES.	150MM CENTRES AROUND THE PERIMETER OF EACH SHEET AND 300MM CENTRES TO INTERMEDIATE STUDS. WHERE MORE THAN ONE SHEET FORMS THE BRACE ELEMENT EACH SHEET MUST BE NAILS OF INDEPENDENTLY
EPBG EPG	ONE LAYER OF 7MM ECOPLY BARRIER EXTERIOR WALL ONE SIDE ONE LAYER OF 10MM OR 13MM GIB STANDARD PLASTERBOARD OTHER SIDE	GIB HANDIBRAC	50x2.8mm HOT DIP GALVANISED OR STAINLESS STEEL FLAT HEAD NAILS. PLACE FASTENERS NO LESS THAN 7MM FROM SHEET EDGES.	150MM CENTRES AROUND THE PERIMETER OF EACH SHEET AND 300MM CENTRES TO INTERMEDIATE STUDS. WHERE MORE THAN ONE SHEET FORMS THE BRACE ELEMENT EACH SHEET MUST BE NAILS OF INDEPENDENTLY

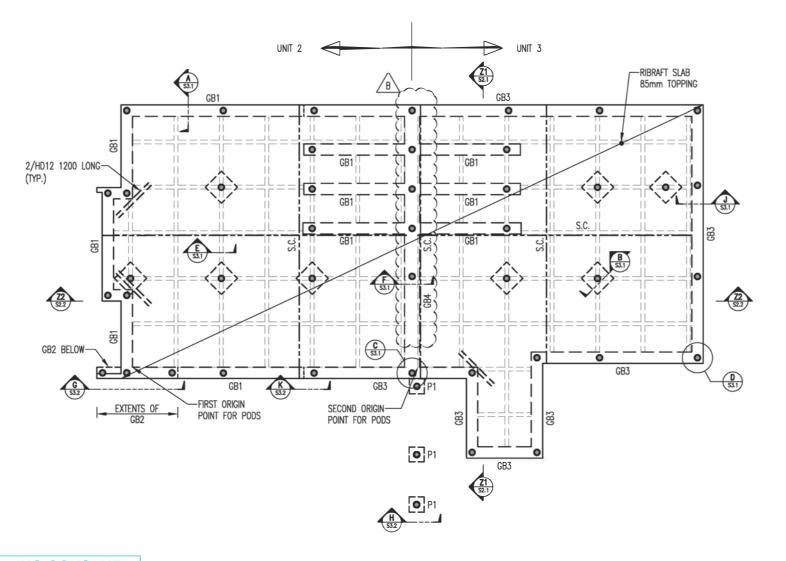

TYPICAL RIBRAFT - 1100x1100x220 PODS, FOUNDATION 100mm RIBS @1200 CRS 85mm TOPPING WITH SE62 MESH 300x305 DEEP CONCRETE GROUND BEAM 300x300 DEEP CONCRETE GROUND BEAM (BELOW GB1) GB3 300x750 DEEP CONCRETE GROUND BEAM 400x305 DEEP CONCRETE GROUND BEAM Ø150 SED DRIVEN PILE, 35kN SWL 0 (50kN ULS) S.C. 25 x 3.0mm SAW CUT (<u>o</u>) 600x600x305 DEEP CONCRETE PILE CAP 400x400x300 DEEP CONCRETE P1**İ O** İ PILE CAP

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	A	BUILDING CONSENT	06/12/2021
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Designed	VM	
Drawn	MC	
Checked	VM	j
Approved	DL	
Client		

Project

FOUNDATION PLAN

Job No.	Sheet	
21104	S1.1	
Date 01/12/2021		
Scale 1:100	Issue B	АЗ

BUILDING CONSENT


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FOUNDATION PLAN

1:2 10 0 20 40 60 80 100 120 140 160 180 200



В3 230x75 PFC B4 230x75 PFC B5 2/240x45 SG8 B6 2/240x45 SG8 В7 230x75 PFC TP1 2/90x45 SG8 TIMBER POST TP2 2/140x45 SG8 TIMBER POST TP3 3/90x45 SG8 TIMBER POST SP2 75x6 SHS STEEL POST LBW INTERNAL LOAD BEARING WALL POSI-STRUT PS25-25x14 @450 CRS ROOF TRUSS BY OTHERS FWI 2/90x45 SG8 STUDS @400 CRS

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	В	BUILDING CONSENT	11/03/2022
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Γ	No.	Revision/Issue	Date

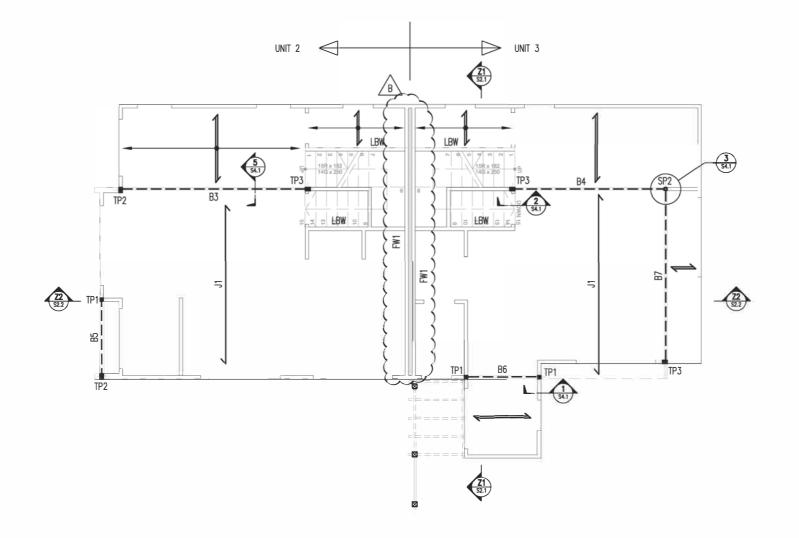

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Approved	DL	
a		

Client

Project

J					
	Job No	٠.	Sheet		
	21104		S1.2		
	Date	01/12/2021			
	Scale	1:100	Issue B	A3	

FIRST FLOOR STRUCTURAL PLAN

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HUTT CITY

10 0 20 40 60 80 100 120 140 160 180 200

B1 2/190x45 SG8
B2 2/190x45 SG8
TP1 2/90x45 SG8 TIMBER POST

ROOF RAFTERS, REFER TO
ARCHITECT
ROOF TRUSS BY OTHERS

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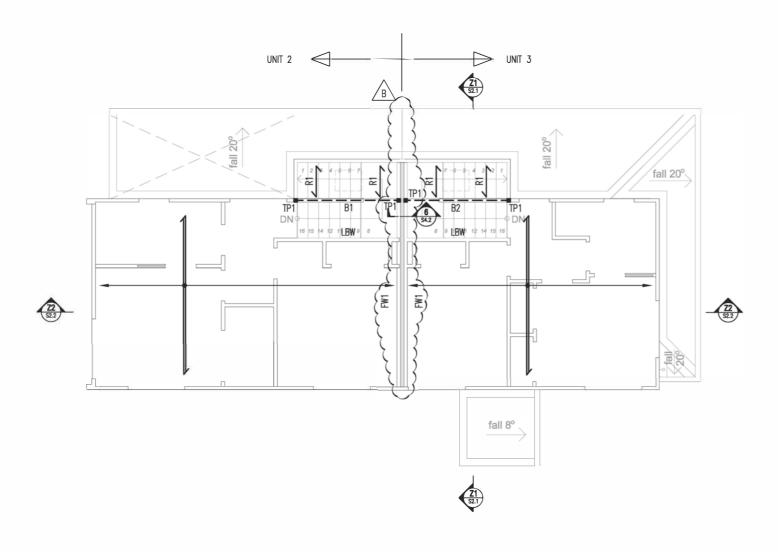
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Project

Drawing Title

ROOF STRUCTURAL PLAN

Job No.	Sheet	
21104	S1.3	
Date 01/12/2021		
Scale 1:100	Issue B	A3



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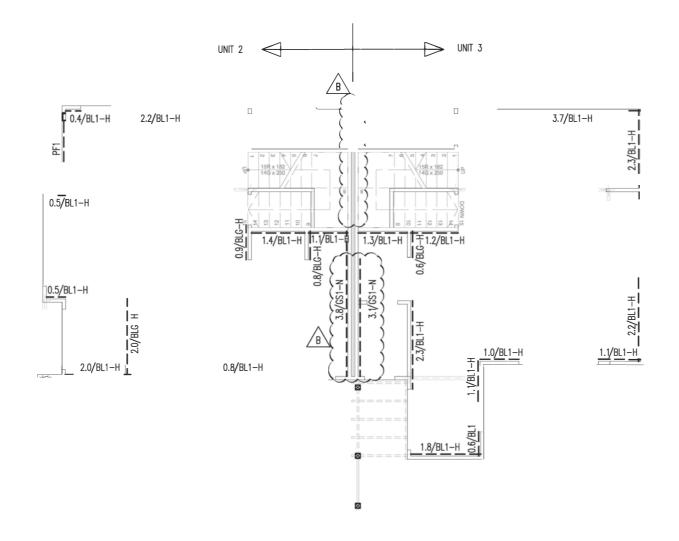
HUTT CITY

TE ANA KAIRARGI

ROOF STRUCTURAL PLAN

.2 10 0 20 40 60 80 100 120 140 160 180 20

30 40 30 00 70 60 30 100



GROUND FLOOR BRACING PLAN

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HUT ITY

PF1 200 PFC PORTAL FRAME

ACROSS ALONG

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B BUILDING CONSENT 11/03/2022

A BUILDING CONSENT 06/12/2021
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Drawn MC
Checked VM
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Project

Drawing Title

GROUND FLOOR BRACING PLAN

Job No. Sheet
21104 S1.4
Date 01/12/2021

cale 1:100 Issue B A3

UNIT 2 UNIT 3 fall 20° 1.4/EP1 ___1.2/EP1 1.4/EP1 0.5/651 N 1.0/GS1-N 0.8/G 1.2/GS1-N 1.0/GS1-N H-1.0/SS1-N _____2.3/GS1-N_ 0.7/<u>GS1-N</u> 0.8/GS1-N 1.1/GS1-N 1.9/GS1-N fall 8°

FIRST FLOOR BRACING PLAN

BUILDING CONSENT

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1.2 10 0 20 40 60 80 100 120 140 160 180 200

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NOTE

ACROSS

ALONG

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A	BUILDING CONSENT	06/12/2021
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Designed	VM
Drawn	MC
Checked	VM
Approved	DL
Client	
Project	
W	
Drawing Title	
FIRST FLOOR B	RACING PLAN


Job No.	Sheet	
21104	S1.5	
Date 01/12/20	021	
Scale 1:100	Issue B	A3

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Approved	DL	

Project

Drawing Title
SECTION Z1

- 51	Job No.				
ì			Shee	Sheet	
		21104	J sz	2.1	
Ì	Date	01/12/2021	1		
	Scale	1:100	Issue	В	A.

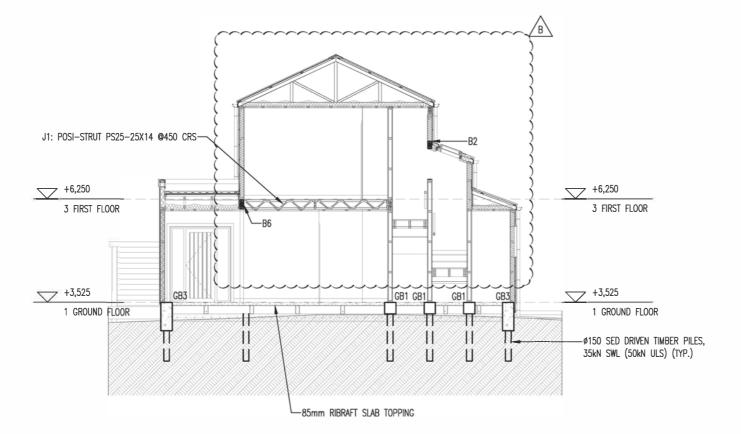1:2 10 0 20 40 60 80 100 120 140 160 180 200


0 This drawing is not to be used for construction unless signed as B5 2/240x45 SG8 approved 230x75 PFC Copyright on this drawing is reserved 300x305 DEEP CONCRETE GROUND BEAM NOTE . THE CONTRACTOR SHALL VERIFY ALL DIMENSIONS ON SITE BEFORE COMMENCING WORK. GB3 300x750 DEEP CONCRETE GROUND BEAM 400x305 DEEP . ALL WORK AND MATERIAL TO COMPLY WITH THE NEW ZEALAND BUILDING CODE. CONCRETE GROUND BEAM 3. ALL DIMENSIONS IN mm. DO NOT SCALE THE DRAWING. USE STATED DIMENSION ONLY . NEW FOUNDATION TO BE FOUNDED ON "GOOD GROUND" ACCORDING TO NZS3604 CONFIRM ON SITE UNIT 3 UNIT 2 J1: POSI-STRUT PS25-25X14 @450 CRS-+6,250 +6,250 3 FIRST FLOOR 3 FIRST FLOOR B7-B5-+3,525 +3,525 GB4 1 GROUND FLOOR 1 GROUND FLOOR -ø150 SED DRIVEN TIMBER PILES, 35kN SWL (50kN ULS) (TYP.) Ú Ш FOCUS ENGINEERING CONS Level 1, 240 Thorndon Quay PO Box 9586, Marion Square Wellington, 6141 P. (04) 382 8678 -85mm RIBRAFT SLAB TOPPING S1.2 SECTION **BUILDING CONSENT** Project **GRANTED** 30/03/2022 Drawing Title **HUTT CITY COUNCIL** SECTION Z2 HUTT/CITY

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	В	BUILDING CONSENT	11/03/2022
	Á	BUILDING CONSENT	06/12/2021
	P1	PRELIMINARY	01/12/2021
	No.	Revision /Issue	Date



Designed	VM	
Drawn	MC	
Checked	VM	
Approved	DL	
Client		

1	Job No.	Sheet	
	21104	S2.2	
	Date 01/12/2021		
	Scale 1:100	Issue B A3	

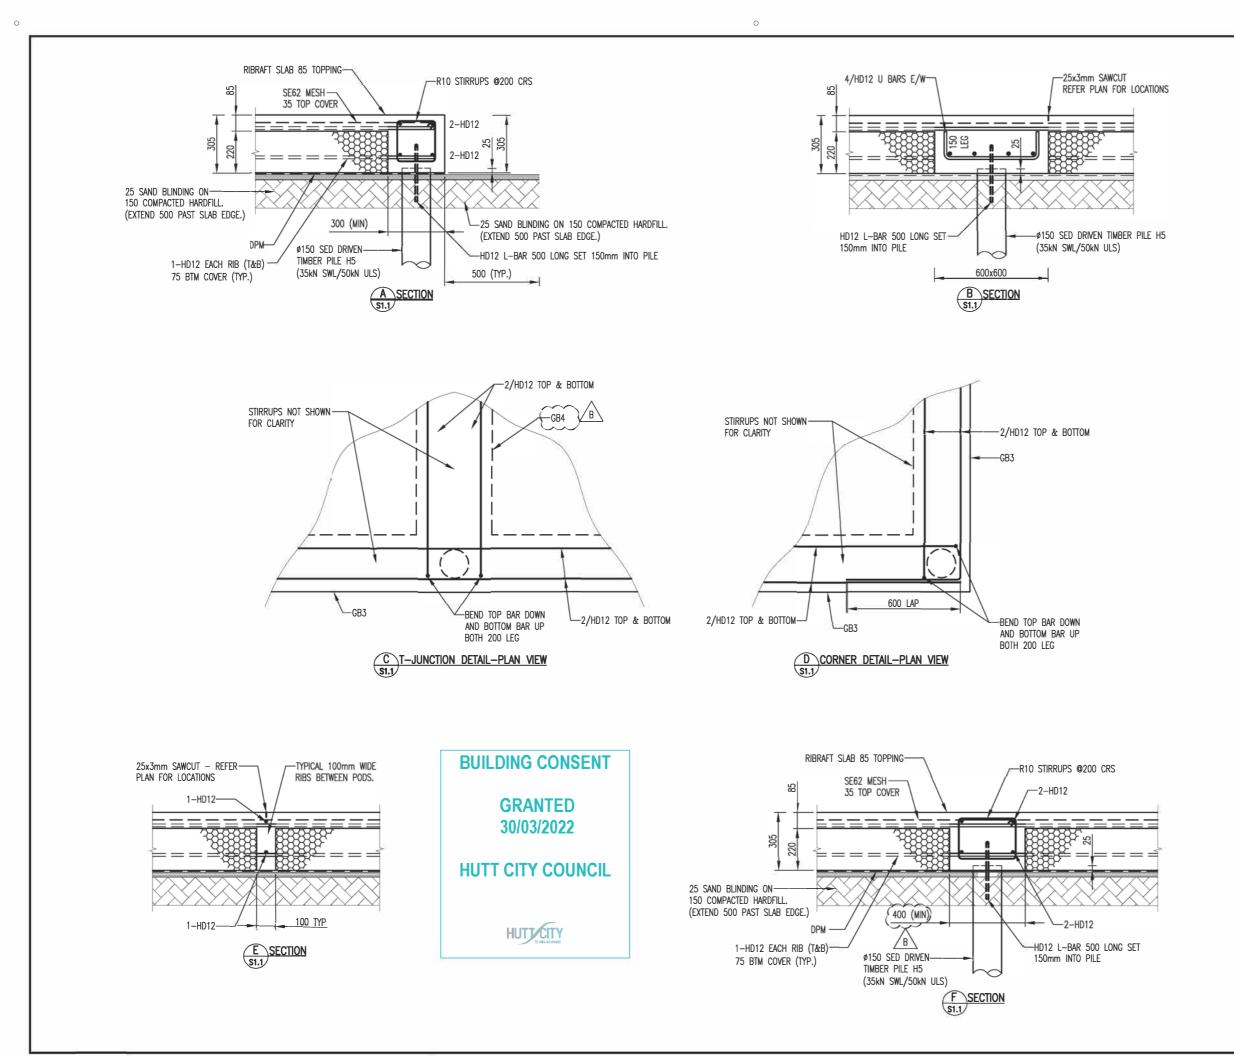

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- 3. ALL DIMENSIONS IN mm. DO NOT SCALE THE DRAWING. USE STATED DIMENSION ONLY
- 4. NEW FOUNDATION TO BE FOUNDED ON "GOOD GROUND" ACCORDING TO NZS3604 CONFIRM ON SITE

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В	BUILDING CONSENT	11/03/2022
A	BUILDING CONSENT	06/12/2021
P1	PRELIMINARY	01/12/2021
No.	Revision/Issue	Date



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ij	Drawn	MC	
	Checked	VM	
	Approved	DL	
	Client		

Project


NEW DWELLINGS

Drawing Title

FOUNDATION DETAILS -1

Job No.		Sheet	
	21104	S3.1	
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210 0 20 40 60 80 100 120 140 160 180 200

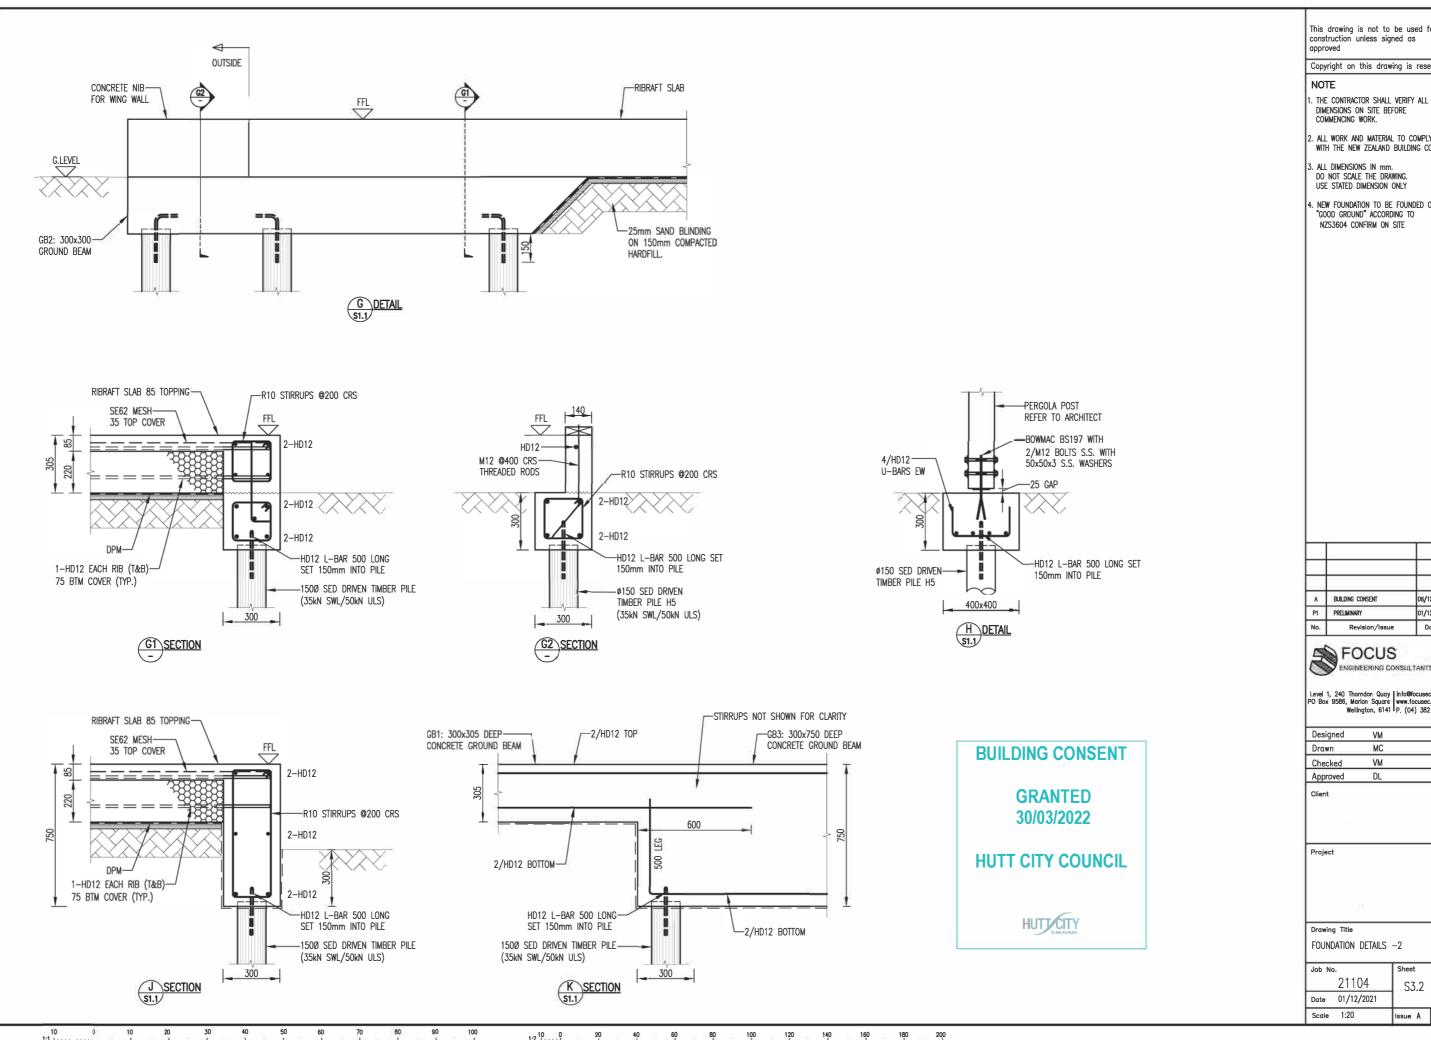

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- 2. ALL WORK AND MATERIAL TO COMPLY WITH THE NEW ZEALAND BUILDING CODE.
- . NEW FOUNDATION TO BE FOUNDED ON "GOOD GROUND" ACCORDING TO

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	A	BUILDING CONSENT	06/12/2021
	P1	PRELIMINARY	01/12/2021
	No.	Revision/Issue	Date




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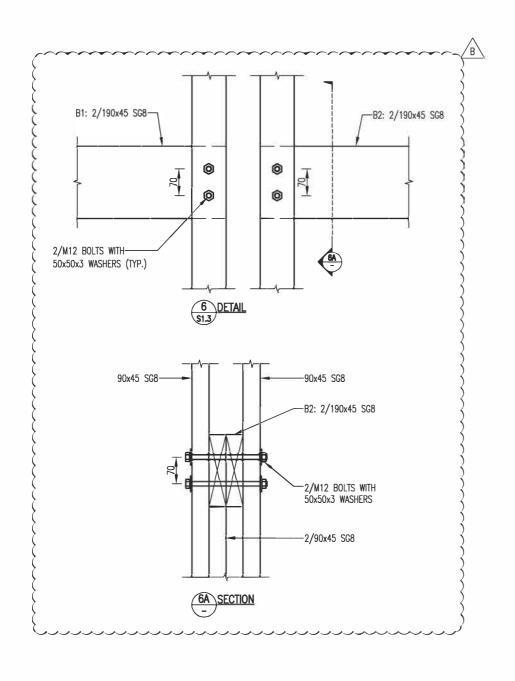
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FOUNDATION	DETAILS	-2
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	Job No.		Sheet	
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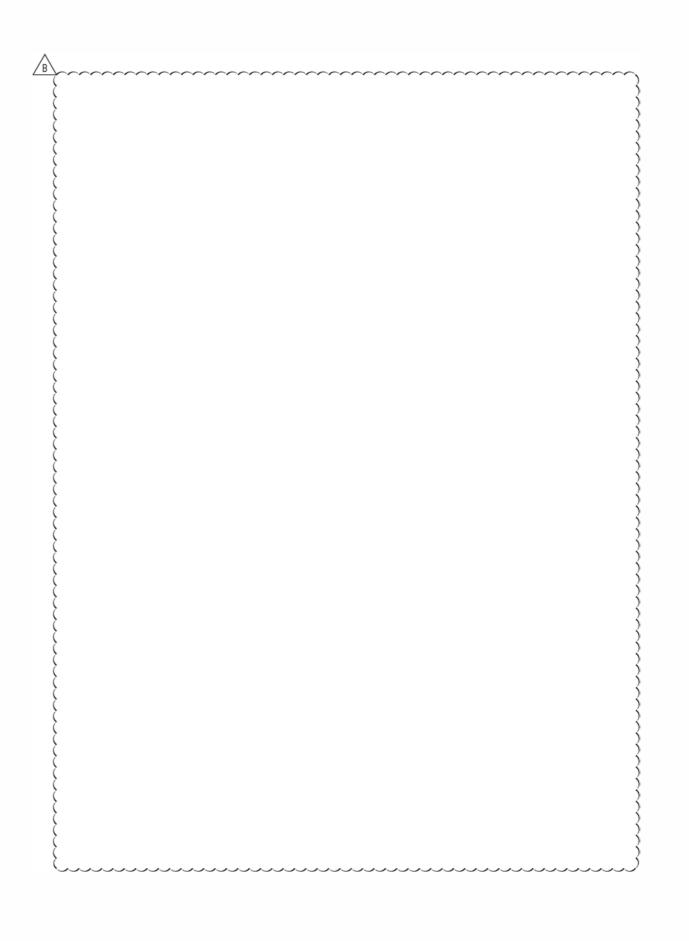


BUILDING CONSENT

GRANTED 30/03/2022

HUTT CITY COUNCIL

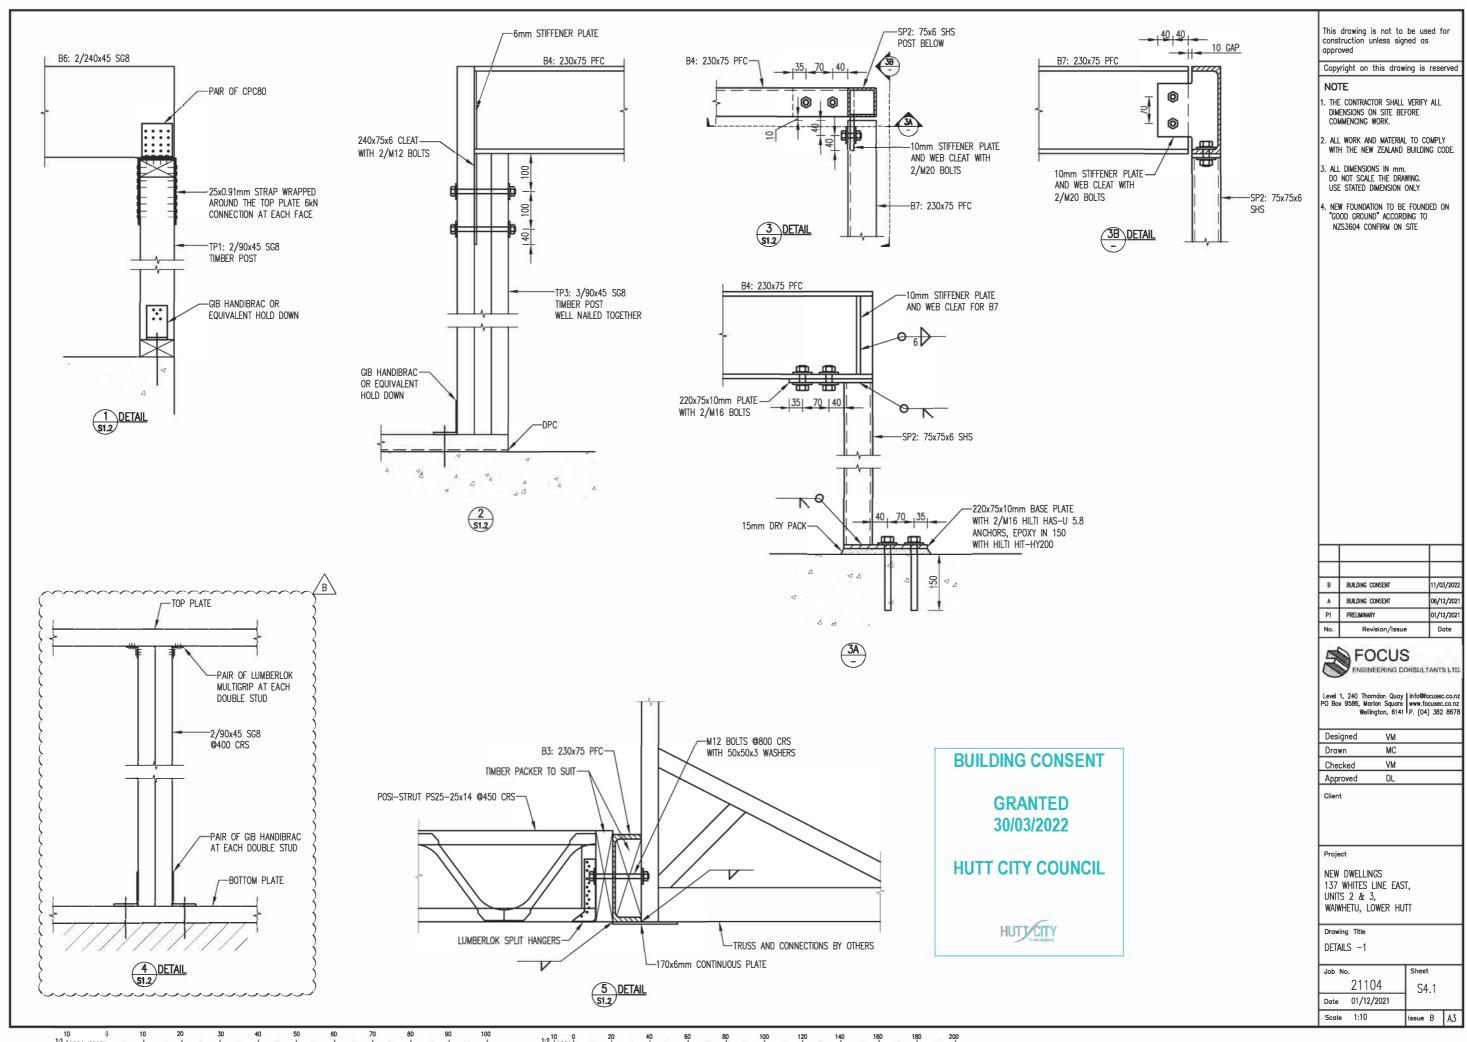HUTT CITY



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- 4. NEW FOUNDATION TO BE FOUNDED ON "GOOD GROUND" ACCORDING TO NZS3604 CONFIRM ON SITE

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В	BUILDING CONSENT	11/03/202
A	BUILDING CONSENT	06/12/202
P1	PRELIMINARY	01/12/202
No.	Revision /Issue	Date



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Designed	VM	
Drawn	MC	
Checked	VM	
Approved	DL	

Project

Drawing Title
DETAILS -2

Job No.		Sheet		
	21104	J S4	1.2	
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Scale	1:10	Issue	В	Α

20 30 40 50 60 70 80 90 100 1:210 0 20 40 60 80 100 120 140 160 1